




JOB NO. F93C817E

SHEET NO. 24 OF 56 SHEETS

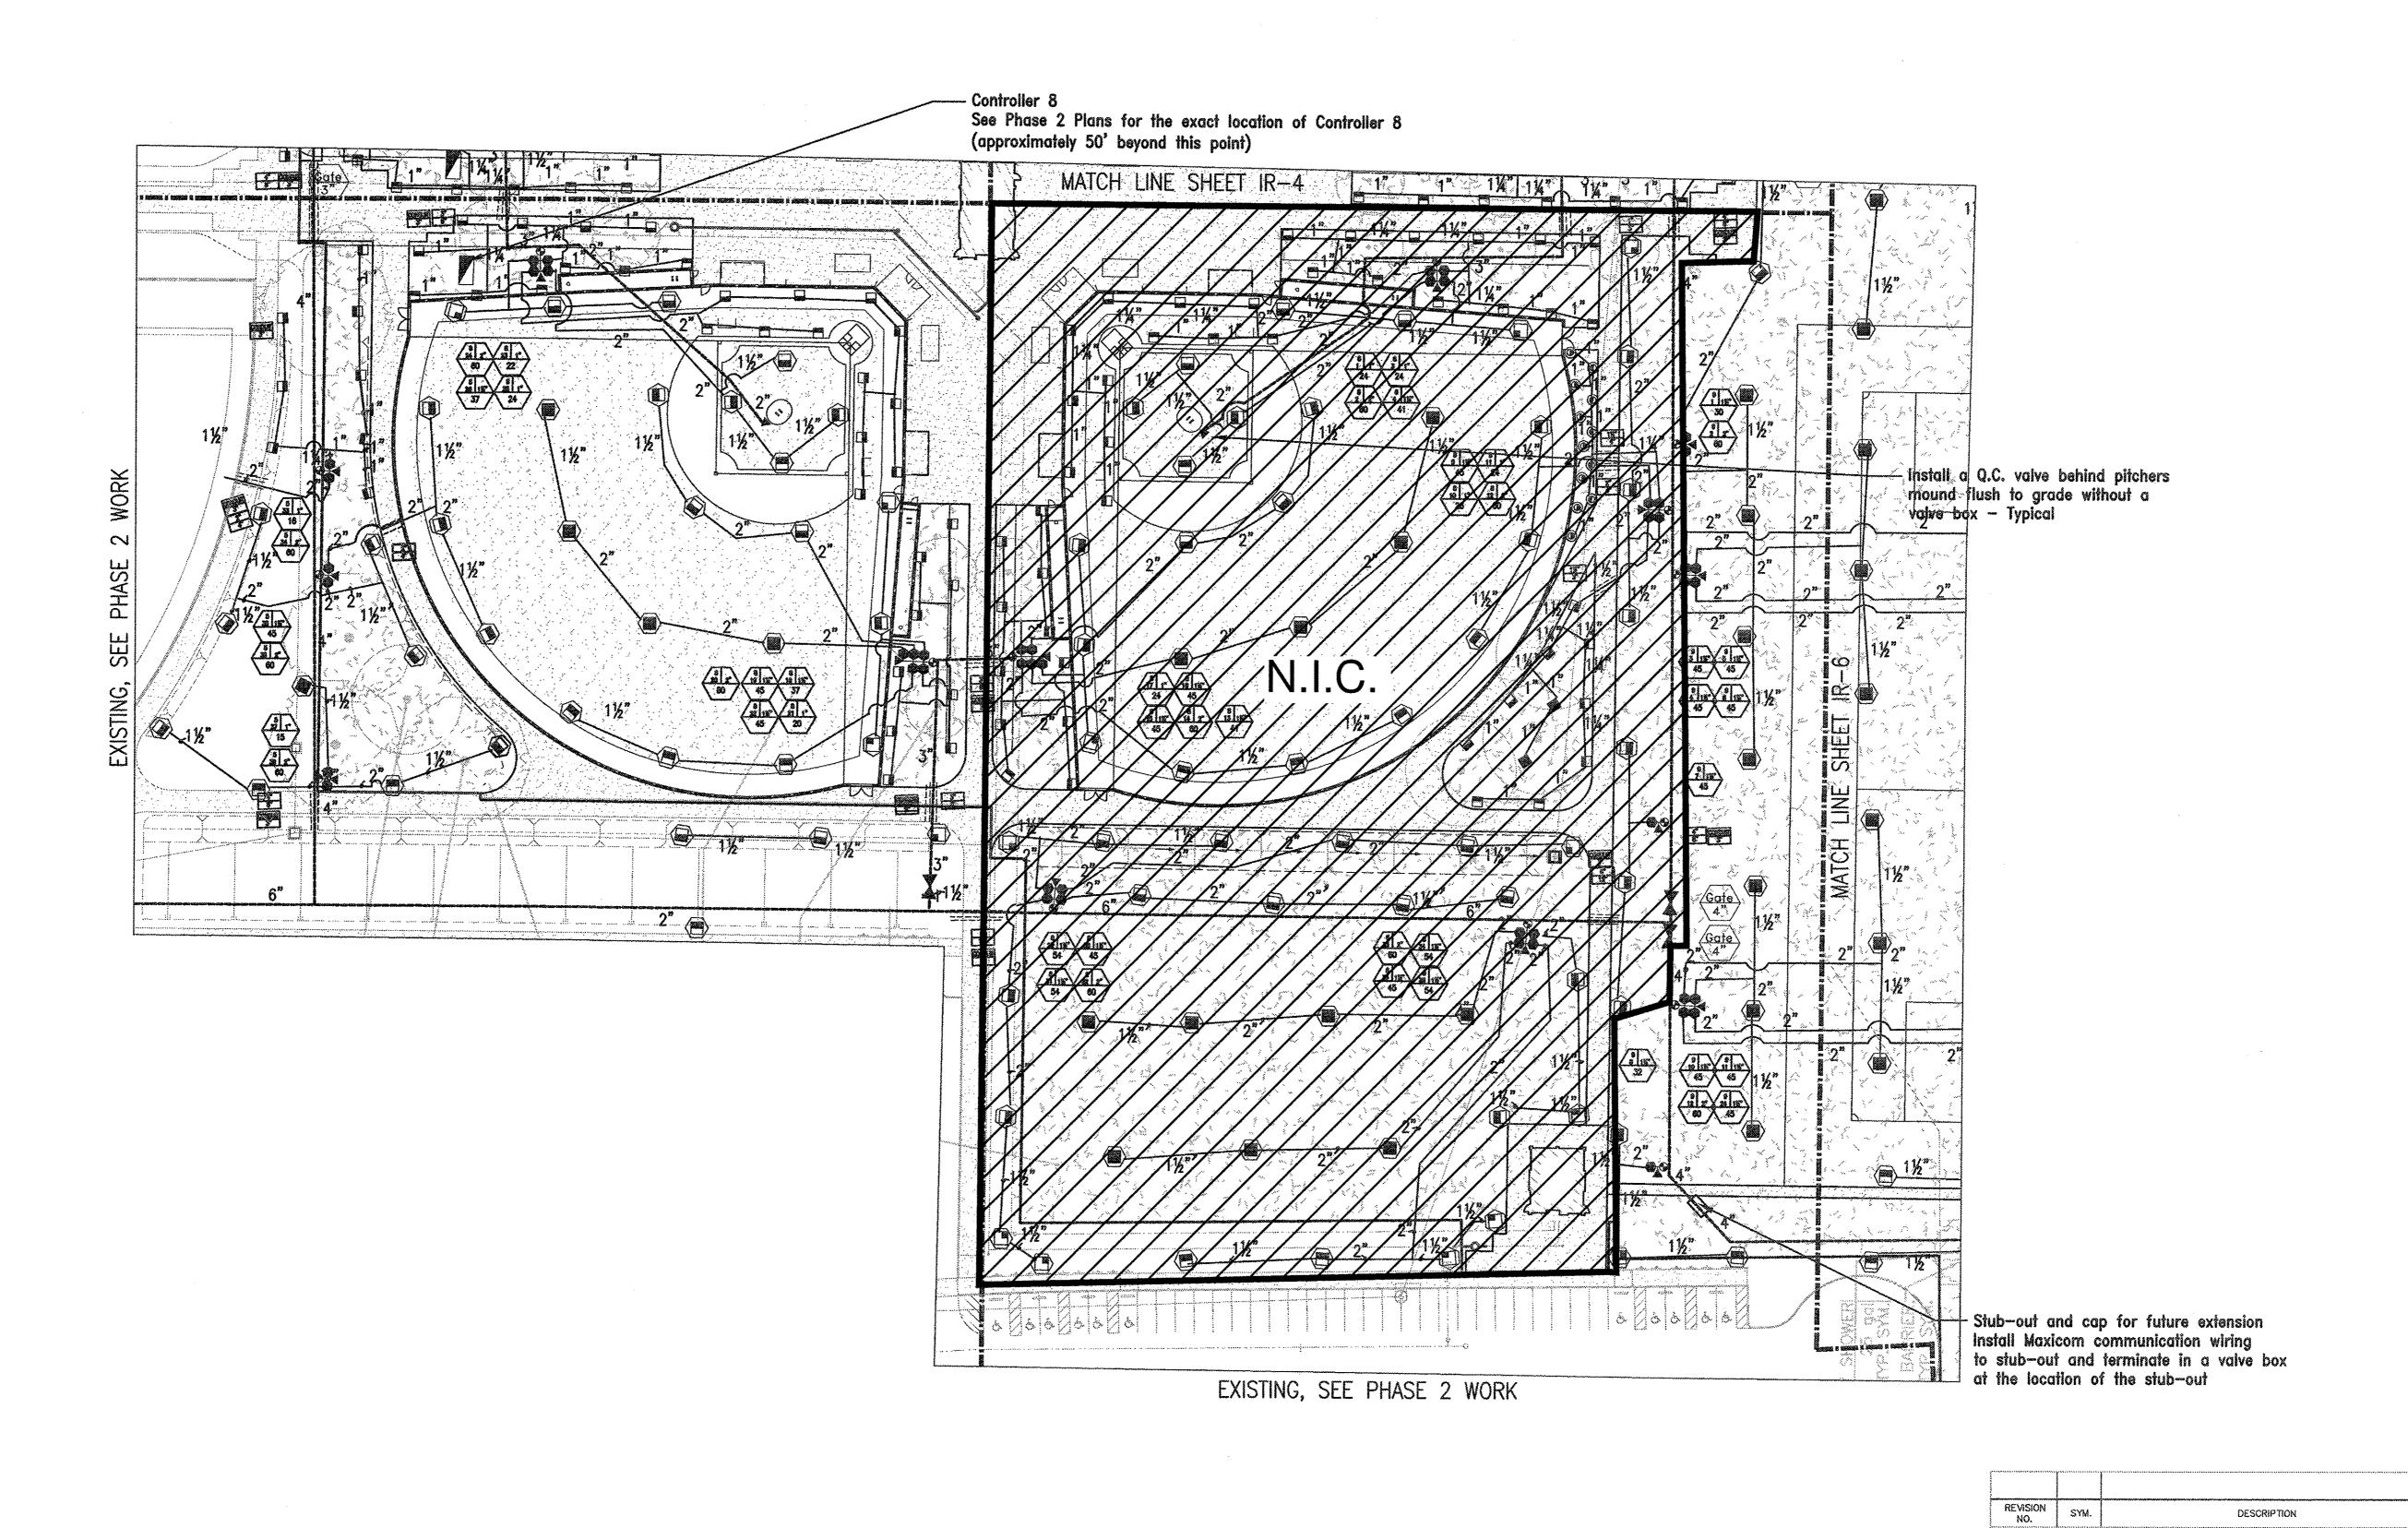

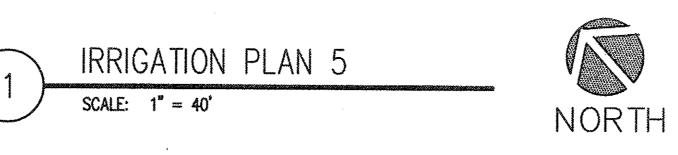

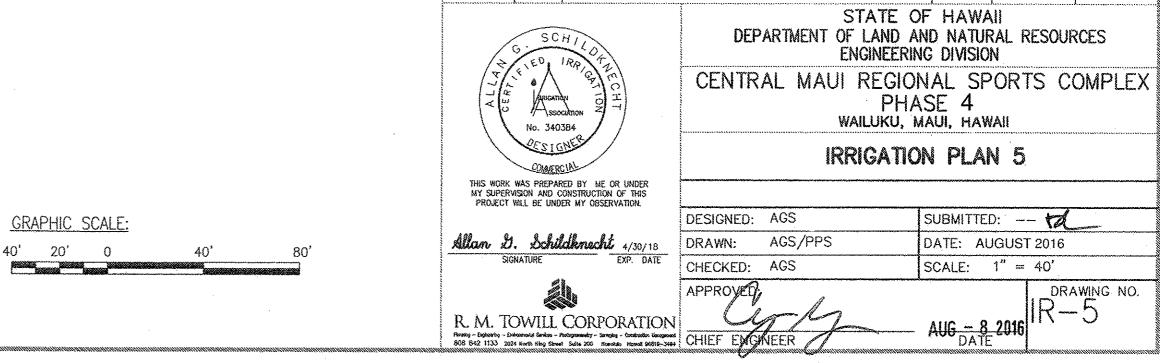

DESCRIPTION


JOB NO. F93C817E


SHEET NO. 25 OF 56 SHEETS

SHT./OF

DATE

APPROVED

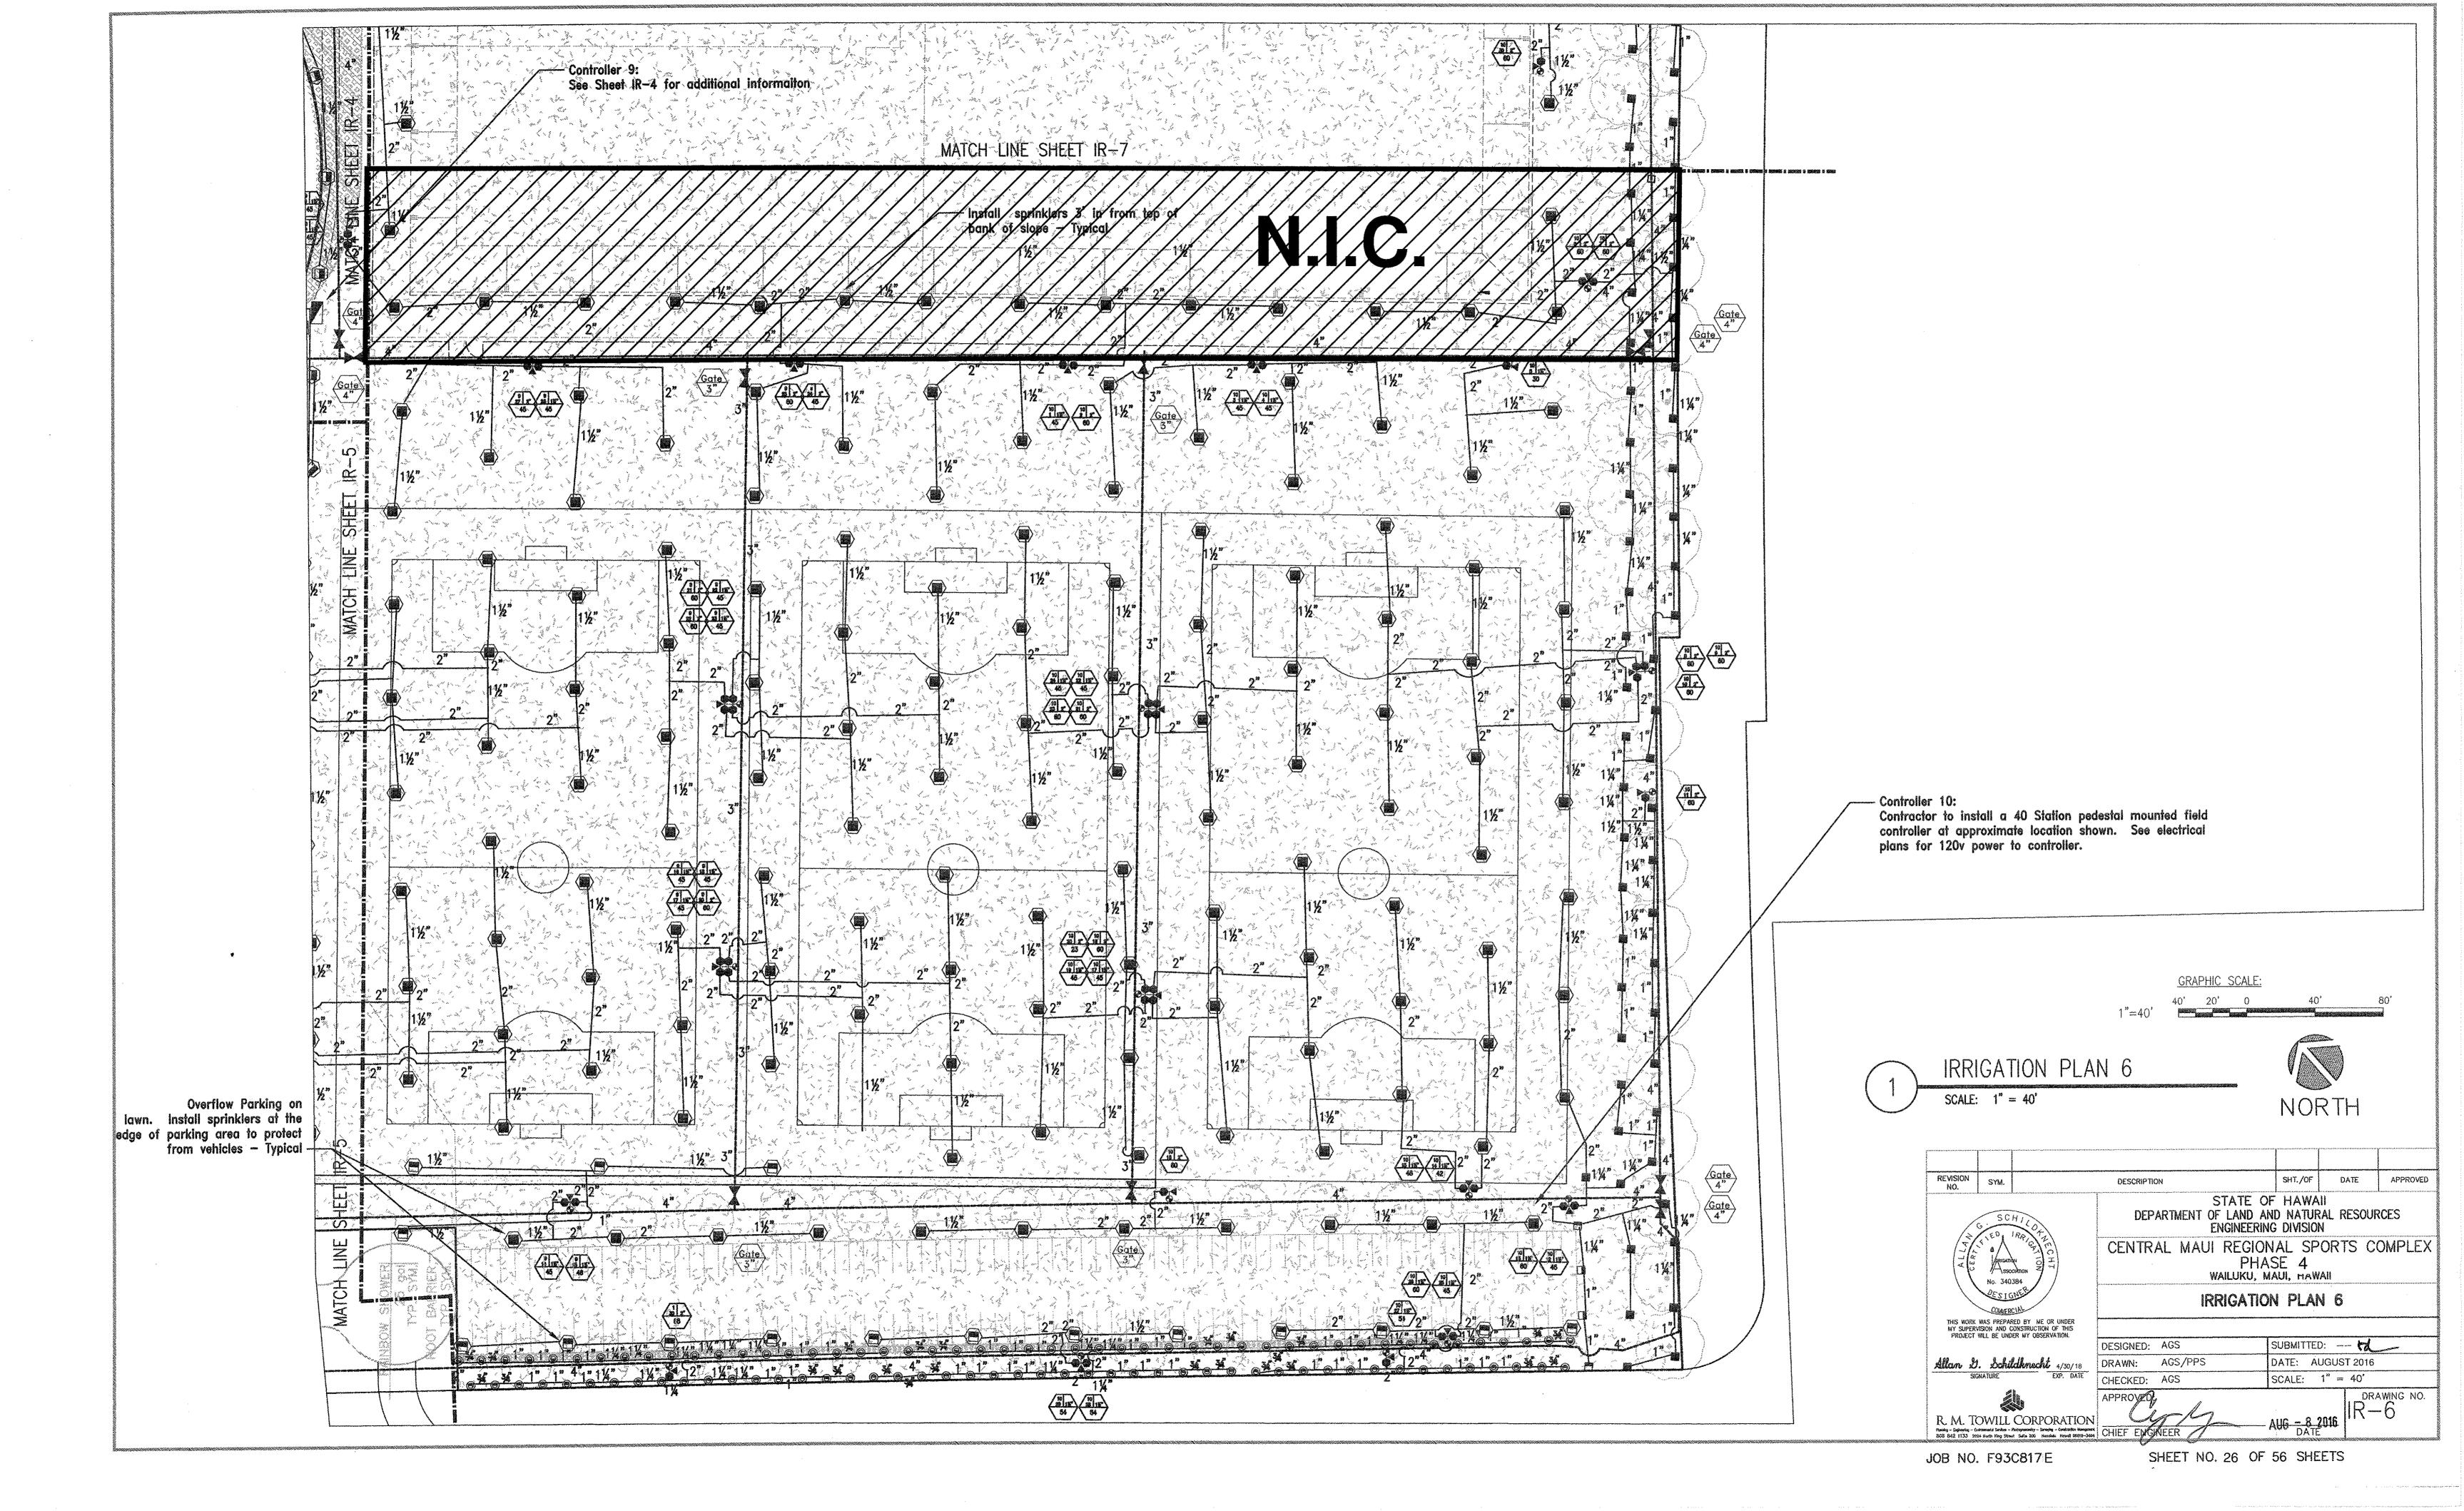

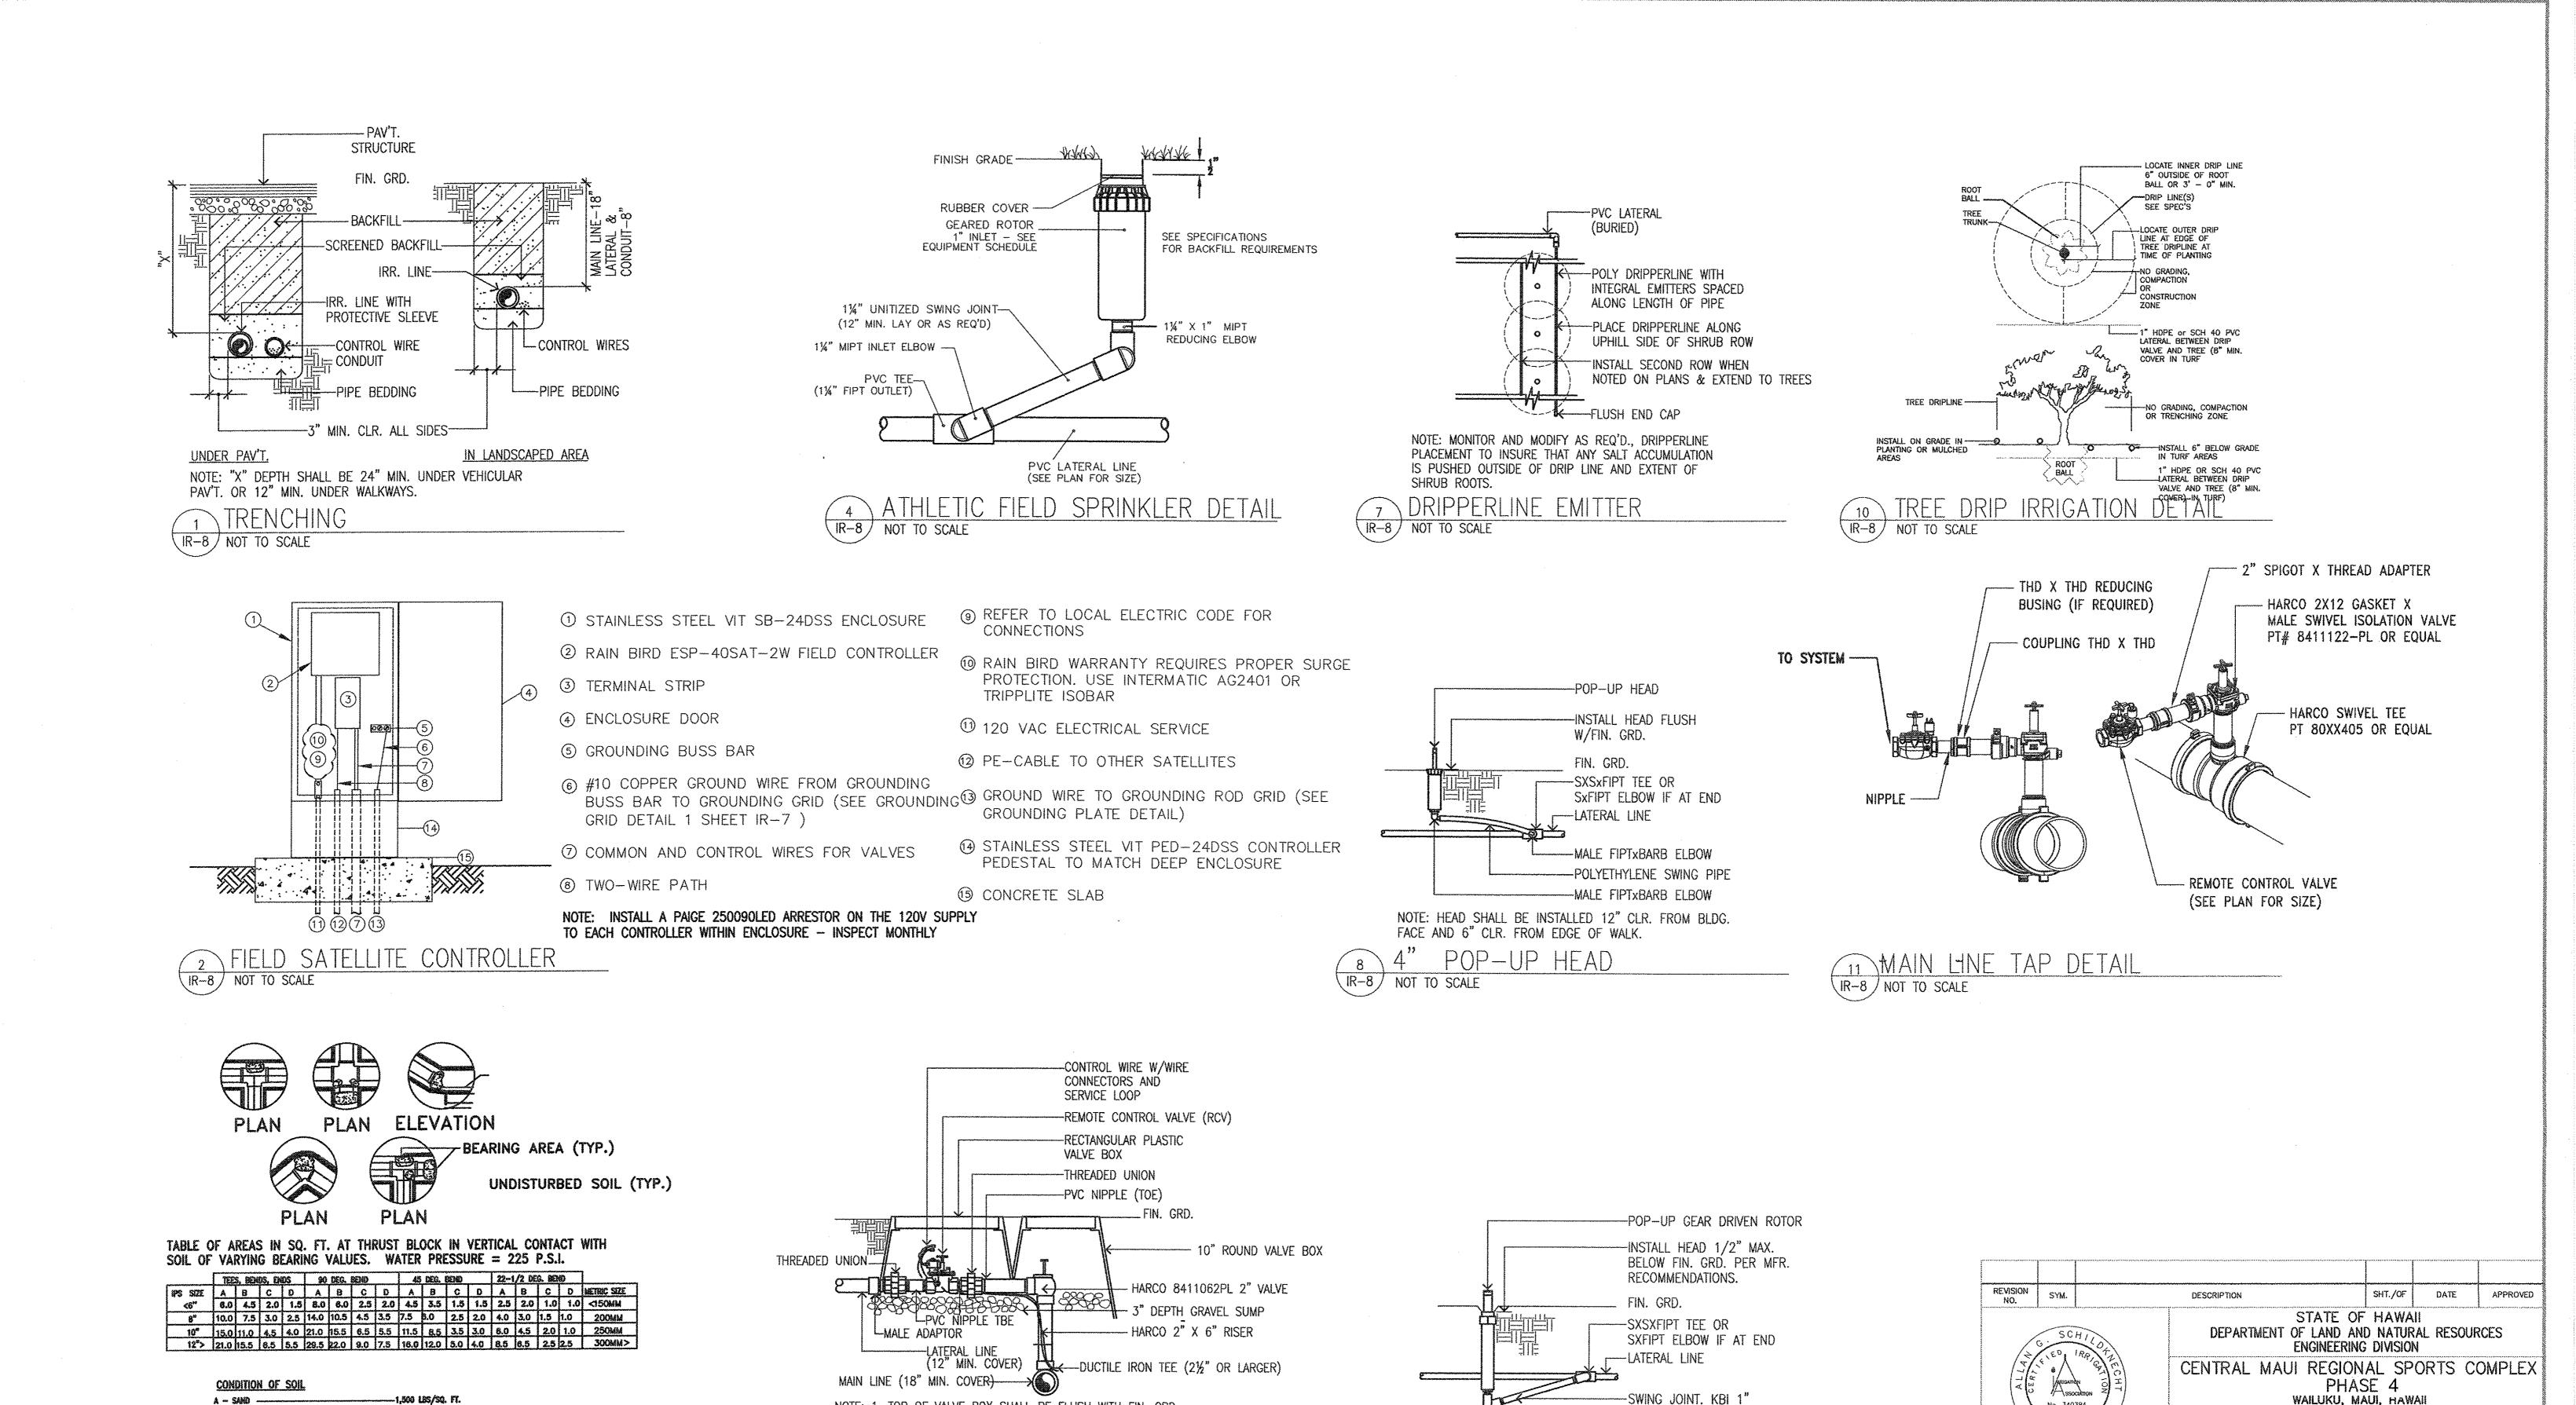

APPROVED SUBSTITUTION. THIS WORK WAS PREPARED BY ME OR UNDER MY SUPERVISION AND CONSTRUCTION OF THIS PROJECT WILL BE UNDER MY OBSERVATION. 3. SEE SPEC'S FOR MINIMUM DEPTH OF COVER OVER PIPING NOTE: HEAD SHALL BE INSTALLED 18" CLR. FROM EDGE 4. UNION BETWEEN MAY & RCV CAN BE AN INTERGRAL PART OF MAY OF WALK OR PAVEMENT. DESIGNED: AGS THRUST BLOCK DETAIL Allan D. Schildknecht 4/30/18 REMOTE CONTROL VALVE-A/C DRAWN: AGS/PPS POP-UP GEAR DRIVEN ROTOR CHECKED: AGS IR-8 / NOT TO SCALE IR-8 NOT TO SCALE (IR-8) NOT TO SCALE R. M. TOWILL CORPORATION Planetog - Bagboratog - Christopeanis Samboe - Photogrammatry - Samaylog - Construction Microgramed BOB 842 1133 3024 March Kiny Street Suita 200 Microbali March S6918-3464 CHIEF

NOTE: 1. TOP OF VALVE BOX SHALL BE FLUSH WITH FIN. GRD.

2. PROVIDE REDUCER BUSHINGS AS REQ'D

IN GRASS, 2" ABOVE GRADE IN GROUND COVER.

--- 2,000 USS/SQ. FT.

C - SAND, GRAVEL, & CEMENTED CLAY 5,000 LBS/SQ. FT. D - SMIF 6,000 LBS/SQ. FT.

SHEET NO. 27 OF 56 SHEETS JOB NO. F93C817E

IRRIGATION DETAILS

SUBMITTED: -- WL


DATE: AUGUST 2016

SCALE: AS NOTED

No. 340384

MIPT X FIPT PVC TRIPLE

SWING ASSEMBLY, OR

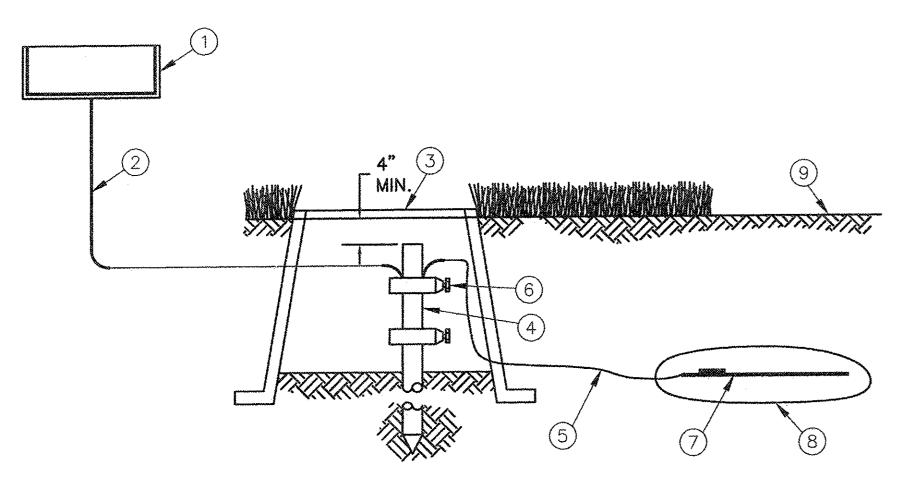

- MAXICOM FIELD SATELLITE, WEATHER STATION OR CCU ASSEMBLY
- SOLID BARE COPPER WIRE (#10 AWG) FROM GROUNDING ROD/PLATE TO SATELLITE, CCU OR WEATHER STATION. MAKE WIRE AS SHORT AS POSSIBLE
- 3 10" VALVE BOX WITH BLACK ELECTRICAL VALVE BOX COVER
- 4) §" X 10 FT COPPER CLAD GROUNDING ROD INSTALL RODS IN SOIL A MINIMUM OF 15 FT APART.
- BARE COPPER WIRE (#6 AWG MIN.) BETWEEN GROUNDING ROD AND GROUNDING PLATE WITH MIN. 10-OHM RESISTENCE AT EACH ROD.
- (6) COPPER GROUND ROD CLAMP OR WELDS
- 7) COPPER GROUNDING PLATE
- GROUNDING ENHANCEMENT MATERIALS (IS EXPECTED TO BE REQUIRED DUE TO SOIL TYPES FOUND ON SITE). ADD AS NEEDED TO MEET THE 10-OHM RESISTANCE NOTED.
- 9) FINISHED GRADE

NOTE: REFER TO RAIN BIRD CENTRAL CONTROL TECHNICAL BULLETIN TB-9001MULTI FOR INSTALLATION GUIDELINES. GROUNDING DETAIL APPLIES TO ALL FIELD SATELLITES, THE CLUSTER CONTROL UNIT (CCU) AND THE WEATHER STATION. ALL UNITS SHALL HAVE A PAIGE #250090LED, MGP-1 AND MSP-1 INSTALLED AS PER RAIN BIRD SPECIFICATION. INSTALLATION MUST BE CERTIFIED BY THE RAIN BIRD SERVICE PROVIDER PRIOR TO ACCEPTANCE OF SYSTEM.

SATELLITE GROUNDING DETAIL

IR-9 NOT TO SCALE

FLOW THROUGH LATERAL

O.O THROUGH 6 GPM

7 GPM THROUGH 12 GPM

1" PIPE

13 GPM THROUGH 22 GPM

1½" PIPE

23 GPM THROUGH 35 GPM

1½" PIPE

36 GPM THROUGH 50 GPM

2" PIPE

51 GPM THROUGH 75 GPM


ALL SMALL NOT EXCEED 75 GPM

ALL SMALL ROTOR CIRCUITS SHALL BE 1" MINIMUM

ALL ATHLETIC FIELD ROTOR CIRCUITS SHALL BE 1-1/2" MINIMUM


4 LATERAL PIPE SIZING CHART

IR-9 TO BE USED FOR LATERAL PIPING NOT OTHERWISE SIZED ONLY

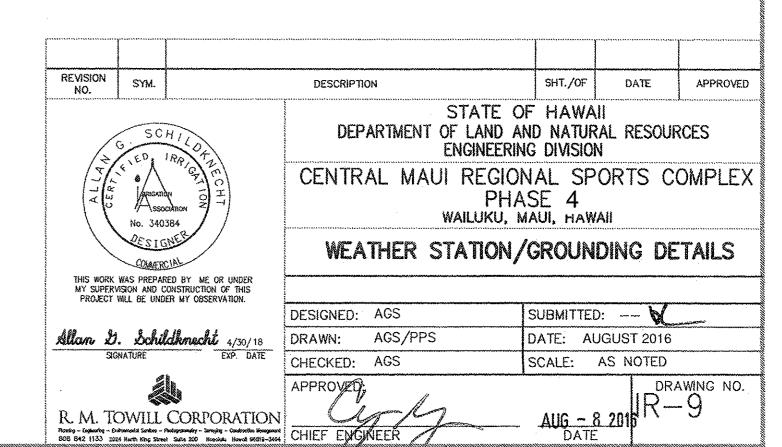


JOB NO. F93C817DE

SHEET NO. 28 OF 56 SHEETS

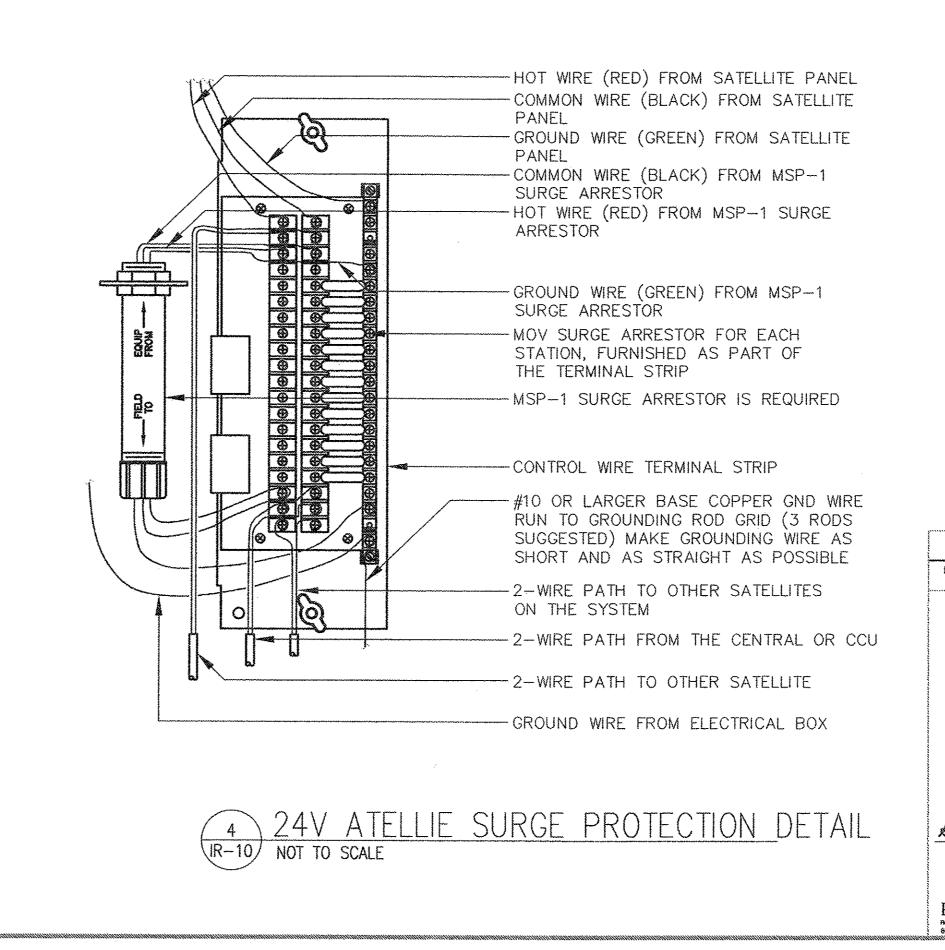

NOTE: ALL FIELD SATELLITE CONTROLLERS, CLUSTER CONTROL UNITS, WEATHER STATIONS AND ANY OTHER 120V POWER UNIT SHALL BE PROTECTED WITH A PAIGE 25090LED LIGHTNING/SURGE PROTECTION UNIT AND.OR AS DIRECTED BY THE MANUFACTURERS RECOMMENDATIONS AT TIME OF INSTALLATION.

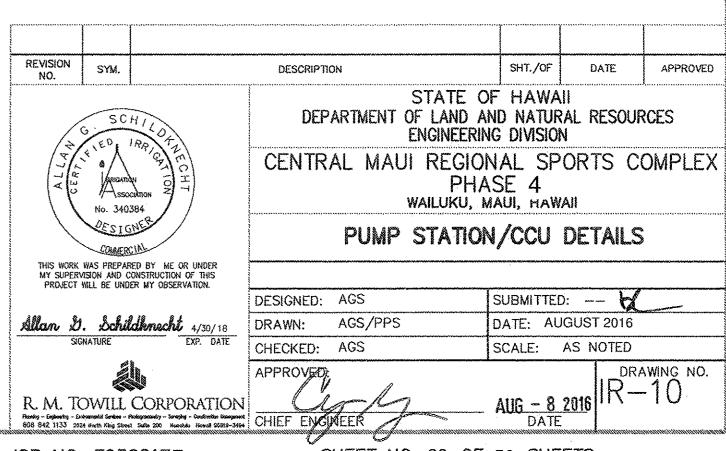

JOB NO. F93C817E

SHEET NO. 29 OF 56 SHEETS

# GENERAL NOTES

- 1. INSPECT THE SITE AND VERIFY CONDITIONS PRIOR TO COMMENCING WITH THE WORK.
  DISCREPANCIES SHALL BE BROUGHT TO THE ATTENTION OF THE OFFICER IN CHARGE. BY
  COMMENCING WITH THE WORK, THE CONTRACTOR ACCEPTS THE EXISTING CONDITIONS AND
  RESPONSIBILITY FOR MAINTAINING THOSE CONDITIONS.
- 2. THE EXISTENCE AND LOCATION OF EXISTING STRUCTURES, UTILITIES AND APPURTENANCES SHOWN OR NOTED ON THESE PLANS ARE FROM THE LATEST AVAILABLE PLANS AND FIELD OBSERVATIONS AND ARE NOT GUARANTEED. SUCH ITEMS ARE NOT GUARANTEED AS TO LOCATION NOR TO THE EXISTENCE OF OTHER OBSTACLES WHICH MAY BE ENCOUNTERED. THE LOCATIONS SHOWN OR NOTED ARE APPROXIMATE ONLY. THE CONTRACTOR SHALL PERFORM AN INDEPENDENT CHECK OF ELEMENTS AND POSSIBLE CONFLICTING STRUCTURES. DISCREPANCIES SHALL BE REPORTED TO THE OFFICER IN CHARGE. REASONABLE MODIFICATIONS TO ACCOMMODATE SITE CONDITIONS SHALL NOT CONSTITUTE A RIGHT TO ADDITIONAL FUNDS.
- 3. EXISTING STRUCTURES, UTILITIES, APPURTENANCES AND LANDSCAPE PLANTINGS, ESPECIALLY TREES, ADJACENT TO CONSTRUCTION LIMITS SHALL BE PROTECTED. EXISTING STRUCTURES, UTILITIES, APPURTENANCES AND LANDSCAPE DAMAGED BY WORK UNDER THIS CONTRACT SHALL BE REPAIRED AT CONTRACTOR'S EXPENSE TO THE SATISFACTION OF THE LANDSCAPE ARCHITECT AND CLIENT. DO NOT PARK ANY EQUIPMENT OR VECHICLES UNDER EXISTING TREES.
- 4. THE CONTRACTOR SHALL NOT DEVIATE FROM THE DRAWINGS AND SPECIFICATIONS. IN THE EVENT OF ERRORS OR DISCREPANCIES, THE CONTRACTOR SHALL IMMEDIATELY NOTIFY THE LANDSCAPE ARCHITECT.

# IRRIGATION NOTES

- 1. IRRIGATION SYSTEMS ARE DIAGRAMMATIC AND SUBJECT TO MINOR ADJUSTMENTS DUE TO UNANTICIPATED FIELD CONDITIONS. IRRIGATION HEADS SHALL BE INSTALLED WHERE SHOWN, ADJUSTMENTS TO HEAD PLACEMENT MAY BE MADE IN THE FIELD ONLY TO AVOID OBSTACLES OR TO IMPROVE COVERAGE. HEADS SHALL NOT BE SPACED FURTHER THAN SHOWN ON THE DRAWINGS. VALVES SHALL BE INSTALLED IN THE VICINITY OF THE LOCATIONS SHOWN AND BE ACCESSIBLE FOR SERVICE AND USE. AVOID CONFLICTS WITH PLANTINGS, UTILITIES AND ARCHITECTURAL ELEMENTS. INSTALL ALL VALVES WITHIN GROUND COVER AREAS AND AVOID INSTALLATION WITHIN LAWN AREAS UNLESS OTHERWISE DIRECTED.
- 2. PRIOR TO EXCAVATION FOR IRRIGATION LINES, THE CONTRACTOR SHALL VERIFY IN THE FIELD THE EXACT LOCATION AND DEPTH OF ALL UTILITIES AND EXISTING SYSTEMS IN THE AREA AND EXERCISE CAUTION WHEN EXCAVATING.
- 3. COORDINATE WITH OTHER TRADES TO INSURE INSTALLATION OF IRRIGATION LINES AND APPURTENANCES. IT SHALL BE THE RESPONSIBILITY OF THE IRRIGATION CONTRACTOR TO COORDINATE WITH OTHER CONTRACTORS ON THE JOB TO INSURE THEIR INSTALLATION AND TO PROVIDE PROPER CLEARANCES FOR CONNECTIONS, SLEEVES AND CONDUIT.
- 4. REFER TO ELECTRICAL DRAWINGS FOR 120V WIRING TO CONTROLLERS. CONTRACTOR TO CONNECT CONTROLLER TO 120V WIRING FROM THE J-BAX LOCATED WITHIN 5 FEET OF THE CONTROLLER LOCATION.
- 5. THE IRRIGATION SYSTEM DESIGN IS BASED ON A MINIMUM STATIC PRESSURE OF 95 PSI AT THE POINT OF CONNECTION UNDER STATIC CONDITIONS. CONTRACTOR TO RETEST THE PRESSURE AT THE WATER SOURCE AND REPORT THE RESULTS TO THE IRRIGATION CONSULTANT PRIOR TO STARTING THE IRRIGATION INSTALLATION.
- 6. INSTALL THE IRRIGATION CONTROLLERS AS NOTED ON THE DRAWINGS AND IN ACCORDANCE WITH THE MANUFACTURER'S RECOMMENDATIONS. THE CONTRACTOR, TOGETHER WITH THE APPROPRIATE OWNER'S REPRESENTATIVE, SHALL PROGRAM THE CONTROLLER TO ACCOMMODATE THE LANDSCAPE AND SITE REQUIREMENTS. ALL CONTROLLERS SHALL BE INSTALLED WITHIN A NEMA 3R PLASTIC OR STAINLESS STEEL ENCLOSURE OR AS OTHERWISE NOTED ON PLANS. A TIPPING RAIN GAUGE SHALL BE INSTALLED NEAR THE CCU TO RELAY RAINFALL FROM THE SITE TO THE MAXICOM COMPUTER, PER MANUFACTURERS RECOMMENDATION. INSTALL RAIN GAUGE OUT OF THE IRRIGATED AREA BUT IN AN AREA OF THE PARK SITE MAINTENANCE BUILDING.
- 7. IRRIGATION SYSTEMS SHALL BE OPERATED DURING "OFF PEAK" EVENING HOURS. OPERATION DURING OTHER TIMES SHALL BE WITH THE APPROVAL OF THE PROJECT MANAGER.

IRRIGATION MATERIALS SCHEDULE							
SYMBOL	DESCRIPTION	MANUFACTURER/ CATALOG NUMBER					
	MAXICOM CCU INTERFACE WITHIN A STAINLESS STEEL NEMA 4 LOCKABLE PEDESTAL	CONTACT PACIFIC PIPE COMPANY FOR PRICING AT (808) 455-8700 ATTN: MIKE HAMAMOTO					
	ESP-SITE-SAT 40-2W 40-STA. CONTROLLER WITHIN A VIT SS LOCAKABLE ENCLOSURE	RAIN BIRD FIELD SATELLINE CONTROLLER WITHIN A VIT STRONG BOX SB-24-DSS STAINLESS STEEL NEMA 3R PEDESTAL MOUNTED ENCLOSURE (48"h X 24"W X 20"d)					
	REMOTE CONTROL VALVE WITH PRESSURE REGULATION	RAIN BIRD PESBR-PRS-D WITH PURPLE HANDLE SIZE AS NOTED FOR RECLAIMED WATER APPLICATIONS					
W	WEATHER STATION PREVENTION UNIT	RAIN BIRD WS-PRO2 WEATHER STATION WITH PHONE MODUM INSTALL PER MANUFACTURERS SPELCIFICATIONS					
	GATE VALVE (FULL LINE SIZE)	NIBCO T-113 OR APPROVED EQUAL, 2½" OR LESS EPOXY COATED AWWA RESILIENT SEAT 3" OR LARGER					
	QUICK COUPLER VALVE	RAINN BIRD #55 NP 1-1/2" QUICK COUPLER VALVE PROVIDE 6 KEYS WITH 1" X 1" HOSE SWIVELS FURNISH SIX (6) EACH 1" X 100' HOSE AT TURNOVER					
	HARCO ISOLATION VALVE	HARCO 8411062PL OR EQUAL 2" SIZE X 6" RISER. WITH 3" OR 5" SWIVEL TEE TO MATCH					
医多类类 医隐尼茨 美草霉素	IRRIGATION MAINLINE - PVC	SDR21 CL 200 PVC WITH WARNING TAPE SEE SPEC'S - 18" MIN. DEPTH - SEE RECLAIMED PIPING WATER NOTES ON THIS SHEET FOR ALL PIPING.					
	IRRIGATION LATERAL	SCH 40 PVC, SIZE AS NOTED, 12" MIN. DEPTH SEE RECLAIMED WATER NOTES FOR ALL PIPING					
	PVC SLEEVE UNDER PAVEMENT	SCH 40 PVC PIPE (SIZE AS NOTED) 24"DEPTH					
	IRRIGATION CONDUIT	SCH 40 PVC UL LISTED, SIZE AS NOTED, 12' DEPTH					
Gate 3"	MANUAL VALVE CALL OUT	TYPE OF VALVE (TOP) SIZE OF VALVE (BOTTOM)					
2" 4"	SLEEVE CALL OUT	PIPE SIZE (TOP) WITHIN SLEEVE SIZE (BOTTOM)					
WIRE 2"	CONDUIT CALL OUT	RACEWAY USE (TOP) RACEWAY SIZE (BOTTOM) CONDUIT RACEWAY FOR 24V WIRING (INSTALL ONE EXTRA WIRE THROUGH RACEWAY FOR FUTURE USE)					
CONTROL VALVE CALL OUT							
CONTROLLER No. 3 VALVE SIZE (inches)							
	RACEWAY USE (TOP) RACEWAY SIZE (BOTTOM) CONDUIT RACEWAY FOR 24V WIRING (INSTALL ONE EXTRA WIRE THROUGH RACEWAY FOR FUTURE USE)  CONTROL VALVE CALL OUT  NTROLLER No.  7  VALVE SIZE (inches)						
<b>1</b>							

RRIGATION SPRINKLEF	SCHE	THE	tin alle essent essent de la completa de la comple	landiku asaman menduarkan anukan samulan yipa bupu	***************************************	
INNOAHON SI MINNELI	\ JOHE		······································	***************************************		
HEAD SYMBOL	ANGLE	MANUFACTURER/ CATALOG NUMBER	G.POMP	.M. P.S	SR.S.I. RAD	RAD.
SHRUB SPRAY PRESSURE REGULATING SPRINKLE  12" POP-UP WITH HIGH EFFICIENCY NOZZLES	R	RAIN BIRD RD-1800 SER RD-12-P-NP SERIES WITH U-SERIES NOZZLES OR ACCEPTABLE EQUAL				
	90°		0.85	30	15'	
	120°		1.10	30	15°	
	180°		1.65	30	15'	
	360°		3.60	30	15'	
LAWN SPRAY PRES <u>SURE REGULATING SP</u> RINKLI 4" POP-UP WITH HIGH EFFICIENCY NOZZLES	ER	RAIN BIRD RD-1800 SER RD-04-P-NP SERIES WITH U-SERIES NOZZLES OR ACCEPTABLE EQUAL				***************************************
	90°		0.85	30	15'	
	120°		1.10	30	15'	
	180°		1.65	30	15'	
	240°		2.30	30	15*	
	270°		2.60	30	15'	
	360°		3.60	30	15	
	END STRII		0.45	30	4'X15'	
	SIDE STRI	P	0.85	30	4'X15'	
POP-UP SPRINKLER  STAINLESS STEEL RISER SLEEVE LOW ANGLE NOZZLE		RAIN BIRD 5505 SERIES SHI AS NOTED WITH STAINLESS RUBBER COVER OR APPROVE	STEEL RI	SER AN	D	
LAWN ROTOR SHRUB ROTOR						
	90°		1.6	40	37'	
	180°		2.7	40	39'	
	360°		3.5	40	41'	
ATHLETIC FIELD ROTOR POP-UP SPRINKLER  STAINLESS STEEL RISER SLEEVE WITH NON-POTABLE MARKINGS		RAIN BIRD ATHLETIC FIE 8005-SS-NP-XX SERIE OR ACCEPTABLE EQUAL		OR		
	90°		8	.4	60	49'
	180°		4	5.9	60	65'

# RECLAIMED WATER NOTES

### SPECIAL NOTES - RECLAIMED WATER

A. Marking on the purple PVC piping shall include the following:

"Caution — Recycled (or Reclaimed) Water"; nominal size; PVC—1120; pressure rating in pounds, per square inch at 73°F (23°C); ASTM designations such as 1785, 2241, 2672, 3139. Printing shall be placed continuously on two sides of the pipe.


- B. Warning tape on recycled water constant pressure main line piping must follow these installation specifications:
  - 1. Metallic warning tape shall be used on all constant pressure mains.
  - 2. Warning tape shall be a minimum of 3—inches (76 mm) wide and shall run continuously for the entire length of all constant pressure main line piping. The tape shall be attached to the top of the pipe with plastic tape banded around the warning tape and the pipe every 5 feet (150 cm) on center.
  - 3. Warning tape for the constant pressure recycled water piping shall be purple in color with the words "Caution Recycled (or Reclaimed) Water" imprinted a minimum of 1—inch (25 mm) high and black in color. Imprinting shall be continuous and permanent. Use tape as manufactured by T. Christy Enterprises or approved equal.

- C. All recycled water control valves shall be identified.
  - Identification shall be affixed to each irrigation valve by one of the following methods:
    - (a) Attach tag to control valve stem directly or with plastic tie—wrap.(b) Attach tag to control valve solenoid wire directly or with plastic tie—wrap.
  - 2. Tags shall be weatherproof plastic, 3" x 4", (76 mm x 102 mm) purple in color with the words "Warning Recycled (or Reclaimed) Water Do Not Drink" imprinted on one side, and Avisa Agua Impura No Tomar" on the other side. Imprinting shall be permanent and black in color.
- D. Unless otherwise allowed by local code, all pressure main line piping from the recycled water system shall be installed to maintain 10 feet (3 m) minimum horizontal separation from all potable water piping. Where recycled and potable water pressure main line piping cross, the recycled water piping shall be installed below the potable water piping in a Class 200 purple PVC sleeve which extends a minimum of 5 feet (150 cm) on either side of the potable water piping. Provide a minimum vertical clearance of 6—inches (152 mm). Conventional (white) PVC pipe may be used for sleeving material if it is taped with 3—inch (76 mm) wide purple warning tape which reads "Caution Recycled (or Reclaimed) Water".

## I CONTROL SYSTEM NOTES

1. ALL FIELD CONTROLLERS AND RELATED EQUIPMENT ARE TO BE FULLY COMPATIBLE TO THE EXISTING RAIN BIRD MAXICOM CONTROL SYSTEM MAINTAINED BY THE COUNTY OF MAUI PARKS DEPARTMENT. NO ALTERNATE WILL BE ACCEPTED.

- 2. CONTRACTOR TO SUPPLY THE CLUSTER CONTROL (CCU) UNIT AND TWO DEDICATED TELEPHONE LINES TO THE CCU FOR COMMUNICATION BACK TO THE EXISTING CENTRAL CONTROLLER LOCATED OFF—SITE. (ONE FOR THE CCU AND ONE FOR THE WEATHER STATION).
- 3. ALL CONTROL EQUIPMENT SHALL BE INSTALLED PER THE LATEST RAIN BIRD RECOMMENDATIONS TO INCLUDE THE PROPER GROUNDING, SURGE PROTECTION AND RELATED DATA AVAILABLE AT THE TIME OF INSTALLATION. ALL INSTALLATIONS MUST BE APPROVED BY THE AUTHORIZED RAIN BIRD SERVICE PROVIDER PRIOR TO ACCEPTANCE.
- 4. CONTRACTOR SHALL PAY FOR THE SERVICES OF THE AUTHORIZED RAIN BIRD SERVICE PROVIDER TO PROGRAM THE SYSTEM USING THE ACCURATE AS—BUILT DATA PROVIDED BY THE CONTRACTOR. CONTACT MIKE HAMAMOTO AT (808) 455—8700 FOR A COST TO PROVIDE THIS SERVICE.
- 5. CONTRACTOR SHALL MAINTAIN ACCURATE AS-BUILT DRAWINGS WITH ALL LOCATIONS FIELD LOCATED USING GLOBAL POSITIONING SERVICES (GPS) AS INSTALLED AND SHALL BE AVAILABLE FOR REVIEW AT ANY TIME DURING CONSTRUCTION.

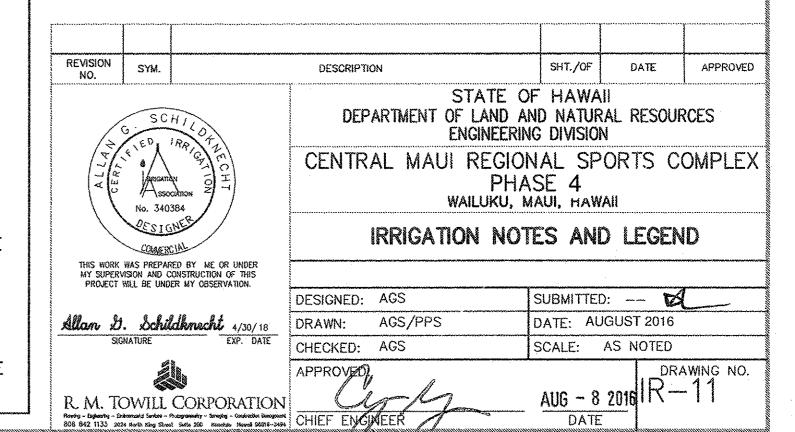

JOB NO. F93C817E

SHEET NO. 30 OF 56 SHEETS

### Architectural Abbreviations **General Notes** <u>Project Data</u> S.N.R. Drinking Fountain G.B. Grab Bar Sanitary Napkin Obscure THE CONTRACTOR SHALL CAREFULLY EXAMINE THE DRAWINGS, READ THE SPECIFICATIONS AND ALL OTHER DET. G.I. O.C. On Center Angle Detail Galvanized Iron Receptacle PROPOSED CONTRACT DOCUMENTS AND SHALL VISIT THE SITE PRIOR TO SUBMITTAL OF HIS BID. THE DIA. 0.D. Outside Diameter Diameter Glass Specification A. International Building Code, 2006 Edition with Maui County Amendments. DIM. (Dim.) CONTRACTOR SHALL FULLY INFORM HIMSELF PRIOR TO THE SUBMISSION AS TO ALL EXISTING CONDITIONS AND Centerline Dimension Ground SQ. Square B. Maui County Code. DISP. Overflow Diameter or Dispenser Grade SST. LIMITATIONS UNDER WHICH THE WORK IS TO BE PERFORMED. HE SHALL INCLUDE IN HIS PROPOSAL, A SUM TO Stainless Steel OFF. Office Perpendicular Gypsum Down S. SK. Service Sink COVER ALL COSTS OF ALL ITEMS NECESSARY TO PERFORM THE WORK AS SET FORTH IN THE PROPOSED Opening 2. Site Data Pound or Number Door STA. Station CONTRACT DOCUMENTS. NO ALLOWANCE SHALL BE MADE TO THE CONTRACTOR BECAUSE OF LACK OF SUCH Existing OPP. Opposite Hose Bibb Drawer STD. Standard Refer to Civil Drawings A. T.M.K: EXAMINATION OR KNOWLEDGE. THE SUBMISSION OF A BID SHALL BE CONSTRUED AS CONCLUSIVE EVIDENCE THAT Downspout Hollow Core STL. Steel PRCST. D.S.P. Air Conditioning Dry Standpipe Hardwood Precast STOR. THE BIDDER HAS MADE SUCH EXAMINATION. Storage B. Lot Area: Refer to Civil Drawings ACCOUS. Plate Acoustical Drawing Hardware STRL. Structural 2. IF ANY CONTRACTOR IS IN DOUBT AS TO THE TRUE MEANING OF ANY PART OF THE CONTRACT DOCUMENTS, OR H.M. Plastic Laminate Area Drain SUSP. Suspension HORIZ PLAS. Refer to Civil Drawings Adjustable C. Zoning: East SYM. FINDS DISCREPANCIES IN, OR OMMISSION FROM ANY PART OF THE CONTRACT DOCUMENTS. HE MAY SUBMIT TO Symmetrical AGGR. Aggregate Plywood Each THE STATE A WRITTEN REQUEST FOR INTERPRETATION THEREOF. Aluminum E.J. HGT. Expansion Joint Tread D. Community Plan: Refer to Civil Drawings 3. ALL WORK SHALL BE ACCOMPLISHED IN STRICT ACCORDANCE WITH ALL LOCAL, STATE AND FEDERAL LAWS, **Approximate** EL. Elevation T.B. Towel Bar P.T.D. Architectural Paper Towe T.C. Electrical Top of Curb REGULATIONS, AND STANDARDS HAVING JURISDICTION OVER THIS PROJECT. E. State Land Use Designation: Refer to Civil Drawings Dispenser Asbestos ELEV. (Dim.) TEL. Elevator Telephone ASPH. 4. ALL MATERIALS FOR THIS PROJECT SHALL BE NEW AND FREE FROM ANY AND ALL DEFECTS UNLESS SPECIFIED **Asphalt** Inclusive or Included P.T.D./R. Emergency Dispenser d Tempered INSUL. F. Flood Hazard Zone Area: Refer to Civil Drawings ENCL. Enclosure TER. Insulation Receptacle Terrazzo OTHERWISE. INT. E.P. Electrical Panel Interior Partition T. & G. Tongue and Groove Bituminous EQ. Paper Towel Equal THK. 5. THE CONTRACTOR SHALL BE RESPONSIBLE FOR COORDINATING ALL WORK AMONG THE VARIOUS TRADES AS Thick G. Base Flood Elevation: Refer to Civil Drawings BLDG. Building EQPT. T.P. Receptacle Equipment Jalousie Top of Pavement NECESSARY TO AVOID CONFLICTS AND TO ENSURE THAT ALL WORK IS IN COMPLIANCE WITH THE CONTRACT BLK. Block Electric Water Cooler JAN. T.P.D. Toilet Paper DOCUMENTS. H. Special District(s): N/A BLKG. Blocking EXST. Existing Joint Quarry Tile Dispenser EXPO. Exposed Toilet Paper Holder 6. THE CONTRACTOR SHALL PROVIDE AND MAINTAIN A SAFETY BARRICADE AROUND THE PROJECT SITE AND SHALL BOT. **Bottom** EXP. Kitchen T. V. Expansion Television ASSURE THE SAFETY OF THE PUBLIC AT ALL TIMES. 3. Planning Data Proposed (Actual) Allowable/Required **Basaltic Termite** EXT. K.O. Exterior Knock-Out RAD. T.W. Radius Top of Wall A. Floor Area Ratio: Barrier E.I.F.S. Exterior Insul. Fin. TYP. Roof Drain Typical 7. THE CONTRACTOR SHALL BE RESPONSIBLE FOR PROVIDING ALL BLOCKING, BACKING, BRACKETS, ETC. AS Laboratory System Reference REQUIRED FOR THE PROPER AND SECURED INSTALLATION OF ALL MATERIALS AND PRODUCTS Cabinet LUM. B. % Lot Coverage: Luminate Unfinished Refrigerator N/A Catch Basin LAV. U.O.N. Unless Otherwise Fire Alarm Lavatory RGTR. Register 8. THE CONTRACTOR SHALL REPORT ANY UNSATISFACTORY CONDITIONS AND/OR DISCREPANCIES TO THE ENGINEER. CEM. Cement F.B. Flat Bar LKR. Locker Noted Reinforced C. Building Height: FAILURE TO COMPLY WITH THIS CONDITION MAY RESULT IN PLACING ANY AND ALL RESPONSIBILITY, LIABILITY AND Ceramic Floor Drain Light Urinal Required EXPENSE TO THE CONTRACTOR. 1. Restroom Building(s): Cast Iron Foundation RESIL Resilient 17'-1" CLG. Ceiling Fire Extinguisher Maximum Vertical 16 -11" 9. THE CONTRACTOR SHALL REVIEW THE PROJECT FOR ANY LONG LEAD ITEMS AND PROVIDE SPECIAL CLKG. Caulking VEST. Fire Extinguisher Medicine Cabinet R.O. Vestibule Rough Opening CLO. Closet Cabinet MECH. RWD. CONSIDERATIONS TO AVOID UNNECESSARY DELAYS TO THE COMPLETION OF THE PROJECT. Mechanical Redwood CLR. F.H.C. Fire Hose Cabinet Membrane West 4. Building Data Allowable/Required Proposed (Actual) C.M.U. 10. THE CONTRACTOR SHALL NOTIFY THE ENGINEER IMMEDIATELY UPON ENCOUNTERING ANY HAZARDOUS MATERIALS, Concrete Masonry With Finish A. Occupancy: Unit ETC. DURING THE COURSE OF THIS PROJECT. THE CONTRACTOR IS NOT AUTHORIZED TO HANDLE, TEST OR W.C. Water Closet Floor Manufacturer Solid Core CNTR. Counter WD. Manhole S.C.D. Wood FLASH. Flashing Seat Cover REMOVE SUCH MATERIALS WITHOUT SPECIFIC AUTHORIZATION FROM THE ENGINEER. COL. Column WDW. FLUOR. Minimum Window 2. Concession Building(s): Fluorescent Dispenser CONC. 11. THE CONTRACTOR SHALL FIELD VERIFY ALL DIMENSIONS AND CONDITIONS PRIOR TO THE FABRICATION AND/OR Concrete Water Heater W.H. Face of Concrete a. Men, Women, Storage: U / Utility COND. Condition W/O Face of Finish Without Soap Dispenser ORDERING OF MATERIALS. b. Concession: B / Business CONN. Connection Face of Studs M.O. F.O.S. Masonry Opening S.D. BD. Sound Deadening Waterproof CONSTR. Construction 12 THE CONTRACTOR SHALL STOP WORK & NOTIFY THE ENGINEER IMMEDIATELY UPON ENCOUNTERING ANY Water Resistant FPRP. Mounted Fireproof Board CONT. Continuous B. Separation: MUL. N/A Mullion WSCT. Wainscot Frame ARCHAEOLOGICAL ARTIFACTS, ETC. DURING THE COURSE OF THIS PROJECT. THE CONTRACTOR IS NOT Section Corridor WT. Finish System AUTHORIZED TO PROCEED WITH WORK IN THE AREA WITHOUT SPECIFIC AUTHORIZATION FROM THE ENGINEER. C.R.M. Concrete Rubble FT. Foot or Feet North Welded Wire Fabric C. Type of Construction: Shower V-BMasonry Not in Contract Footing SHT. Sheet 13. THE CONTRACTOR SHALL OBTAIN AND PAY FOR ALL BUILDING PERMITS FEES & INCIDENTAL PERMIT FEES NO. or # Number Center FURR. Furring SIM. Similar REQUIRED BY THE VARIOUS GOVERNMENT & PUBLIC UTILITIES AGENCIES. D. Max. Floor Area — Table 503: CTSK. Countersunk FUT. Future Slope 5.500 s.f. (max) 1. Restroom Building(s): Not to Scale 704 s.f. SLDG. Sliding 14. PRODUCTS SPECIFIED AND/OR INDICATED BY NAME IN THESE DRAWINGS AND/OR SPECIFICATIONS ESTABLISH A Double -2. Concession Building(s) Gauge Sanitary Napkin 1,520 s.f. (total) DESIGN OR MATERIAL QUALITY DESIRED FOR THIS PROJECT. THE PRODUCTS OF OTHER MANUFACTURERS ARE DEPT. Department GALV. Galvanize Overall - a. Men, Women, Storage Dispenser 704 s.f. ACCEPTABLE PROVIDED THAT THEY MEET OR EXCEED THE MATERIAL AND CONSTRUCTION REQUIREMENTS SPECIFIED 256 s.f. AND/OR HEREIN ACCEPTED BY THE ENGINEER. Material Indications C. Max. Building Height — Table 503: 15. WORK SHALL COMPLY WITH THE 2010 ADA STANDARDS FOR ACCESSIBLE DESIGN WHERE INDICATED ON DRAWINGS 1. Restroom Building(s): AND OR SPECIFICATIONS. 1 story (actual) 1 story (max) 2. Concession Building(s) EARTH **PLYWOOD** 2 story (max) GYPSUM BOARD ROCK FILL 5. Ventilation - IBC 1203 <u> Proposed - Screen Block</u> <u>Required</u> Project Notes OMIT DOUBLE LINES AT SMALL SCALE $704 \times .04 = 28.2 \text{ s.f.}$ 92 s.f. A. Restroom Building(s) $1.520 \times .04 = 60.8 \text{ s.f.}$ WOOD, FRAMING SAND / MORTAR / PLASTER B. Concession Building(s) THROUGH MEMBER THE CONTRACTOR, SUB-CONTRACTORS, VENDORS, AND SUPPLIERS OF SERVICES AND MATERIALS. WITH THE WOOD, FRAMING INTENT OF SUBMITTING PROPOSALS AND PARTICIPATING IN THE CONSTRUCTION OF THIS PROJECT. SHALL CAST IN PLACE OR PRECAST INTERRUPTED MEMBER CAREFULLY EXAMINE THE DRAWINGS AND SPECIFICATIONS. THE CONTRACTOR IS FOREWARNED THAT THE SPECIFICATIONS HAS EXTENSIVE AND COMPREHENSIVE REQUIREMENTS AND INSTRUCTIONS TO ASSIST AND C.M.U. CONCRETE MASONRY UNIT **WOOD STUDS** REGULATE THE WORK OF THIS PROJECT. FAILURE BY THE CONTRACTOR TO EXAMINE THESE CONSTRUCTION DOCUMENTS SHALL NOT RELIEVE HIM/HER OF HIS/HER RESPONSIBILITY TO PROVIDE THESE REQUIREMENTS AS A PART OF THE BID PROPOSAL. Architectural Symbols 2. THE CONTRACTOR SHALL REVIEW ALL SPECIFICATION SECTIONS FOR THE REQUIREMENTS OF THIS PROJECT. THE CONTRACTOR IS CAUTIONED THAT IT SHALL NOT BE TAKEN FOR GRANTED THAT THE WORK OF ONE SECTION DOES NOT CONTAIN WORK RELATED TO OTHER SECTIONS. THE CONTRACTOR COULD ALSO EXPECT TO FIND DRAWING IN SEQUENCE ----DISCIPLINES: PRODUCTS OR MATERIALS OUT OF THE NORMALLY ASSOCIATED SPECIFICATION SECTIONS FOR THAT PRODUCT. DISCIPLINE -CIVIL ENGINEERING: SUB-CONTRACTORS AND VENDORS SHALL NOT ASSUME THAT THEIR WORK IS CONTAINED ONLY WITHIN CERTAIN DOOR NUMBER REVISION NO. SYM. DESCRIPTION DETAILS ON DRAWING -> D LANDSCAPING: SECTIONS OF THE SPECIFICATIONS. THE SPECIFICATIONS WITH THE DRAWINGS, AS A WHOLE, IS THE ARCHITECTURAL: STATE OF HAWAII CONSTRUCTION DOCUMENT. STRUCTURAL ENGINEERING: DEPARTMENT OF LAND AND NATURAL RESOURCES ELECTRICAL ENGINEERING **ENGINEERING DIVISION** 3. THE CONTRACTOR SHALL MAINTAIN THE CONSTRUCTION SITE IN AN ORDERLY, NEAT AND CLEAN MANNER. SITE LICENSED PROFESSIONAL ARCHITECT A-1PLUMBING: CENTRAL MAUI REGIONAL SPORTS COMPLEX DEBRIS (E.G. MUD, ETC.), FROM THE DAILY EGRESS BETWEEN THE SITE & THE OFF—SITE STAGING AREA SHALL BE **REVISION** PHASE 4 CLEANED DAILY. A WASH STATION WITH A GRAVEL PIT WILL BE REQUIRED IN THE CONTRACTOR No. 2714 WAILUKU, MAUI, HAWAII STAGING/PARKING AREA. EROSION CONTROL MEASURES WILL ALSO BE REQUIRED. FIRE SAFETY DURING SECTION, WALL SECTION OR DETAIL SECTION CONSTRUCTION SHALL COMPLY WITH ARTICLE 87 OF THE 1988 UNIFORM FIRE CODE. PROJECT DATA, NOTES, ABBREVIATIONS CAN ALSO BE NOTED : SEE DET. A/A-1 OR ICENSE EXPIRATION DATE: 4-30-201 UPON COMPLETION OF THE PROJECT, THE CONTRACTOR SHALL RESTORE ALL DAMAGED AREAS RESULTING FROM THIS WORK WAS PREPARED BY THE CONSTRUCTION OF THIS PROJECT. SHOULD DAMAGES BE MORE SEVERE. THE ENGINEER MAY REQUIRE ME OR UNDER MY SUPERVISION. SUBMITTED: AY DESIGNED: AY CONSTRUCTION OF THIS PROJECT REPAIRS AND/OR RESTORATION TO BE PERFORMED DURING THE CONSTRUCTION PERIOD. KEY TO ELEVATIONS WILL BE UNDER MY OBSERVATION. DATE: AUGUST 2016 DRAWN: LE, RA (Observation of Construction as defined in the Hawaii Administrative Rules, Dept. of Commerce and Consumer Affairs, Professional Engineers, Architecte, Surveyors and Landscape Architects) CHECKED: AY SCALE: N/A FIRE SAFETY DURING CONSTRUCTION, ALTERATION OR DEMOLITION SHALL BE IN ACCORDANCE WITH 1997 UNIFORM APPROVED/ DRAWING NO. FIRE CODE. ARTICLE 87. DRAWING NAME A-2 = KEY TO ELEVATIONS **A-1** CHIEF ENGINEER

JOB NO. F93C817E

